



GROUND COVERAGE
BLOCK-B

GROUND COVERAGE (BLOCK-B)			
GROSS - A			
1	= 0.5 X 8.148 X 44.268	=	180.348 SQM
2	= 0.5 X 0.899 X 8.148	=	2.726 SQM
3	= 0.5 X 1.859 X 22.658	=	21.091 SQM
4	= 1 X 22.658 X 13.335	=	302.144 SQM
5	= 1 X 83.847 X 31.563	=	2641.823 SQM
6	= 1 X 51.080 X 15.195	=	775.857 SQM
7	= 0.5 X 9.028 X 9.076	=	45.053 SQM
TOTAL			= 3969.012 SQM
NON FAR AREA ON STILT FLOOR			
G. COVERAGE			= GROUND FAR GROSS - A
			= 3969.012
			= 2100.478 SQM

1 ST FLOOR AREA CALCULATION (BLOCK-B)			
GROSS - A			
1	= 0.5 X 1.918 X 10.423	=	9.936 SQM
2	= 0.1 X 1.359 X 10.423	=	1.418 SQM
3	= 0.5 X 3.458 X 5.711	=	1.117 SQM
4	= 1.1 X 20.311 X 10.423	=	238.260 SQM
5	= 0.5 X 8.330 X 13.243	=	109.227 SQM
6	= 1.1 X 17.627 X 8.861	=	139.568 SQM
7	= 1.1 X 24.441 X 27.556	=	684.446 SQM
8	= 1.1 X 2.587 X 25.881	=	66.924 SQM
9	= 1.1 X 53.300 X 28.590	=	600.961 SQM
10	= 1.1 X 2.800 X 28.594	=	58.826 SQM
11	= 1.1 X 31.688 X 27.600	=	486.276 SQM
12	= 1.1 X 27.705 X 3.665	=	81.870 SQM
13	= 0.5 X 4.430 X 4.689	=	6.300 SQM
14	= 1.1 X 85.513 X 4.545	=	75.135 SQM
15	= 0.5 X 0.580 X 2.280	=	0.657 SQM
16	= 1.1 X 6.100 X 2.280	=	13.716 SQM
17	= 1.1 X 4.500 X 0.600	=	2.970 SQM
18	= 1.1 X 4.500 X 0.600	=	2.970 SQM
19	= 1.1 X 2.250 X 1.600	=	3.960 SQM
20	= 1.1 X 11.900 X 0.600	=	6.840 SQM
21	= 1.1 X 11.300 X 2.150	=	24.285 SQM
TOTAL			= 3969.354 SQM
FAR AREA OF 1 ST FLOOR			
GROSS - A			= GROSS - B
			= 3969.356
			= 2675.423 SQM

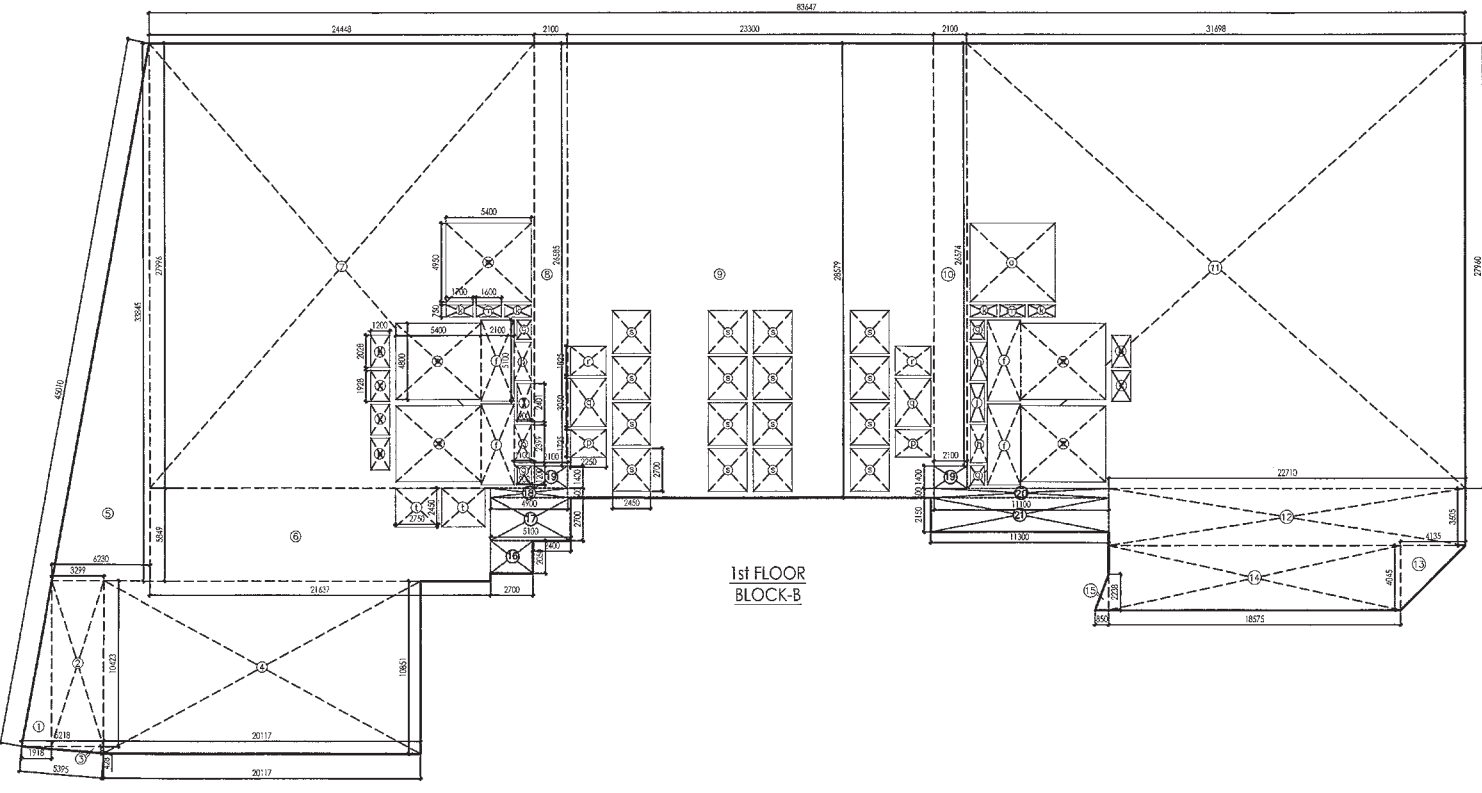


1st FLOOR
BLOCK-B

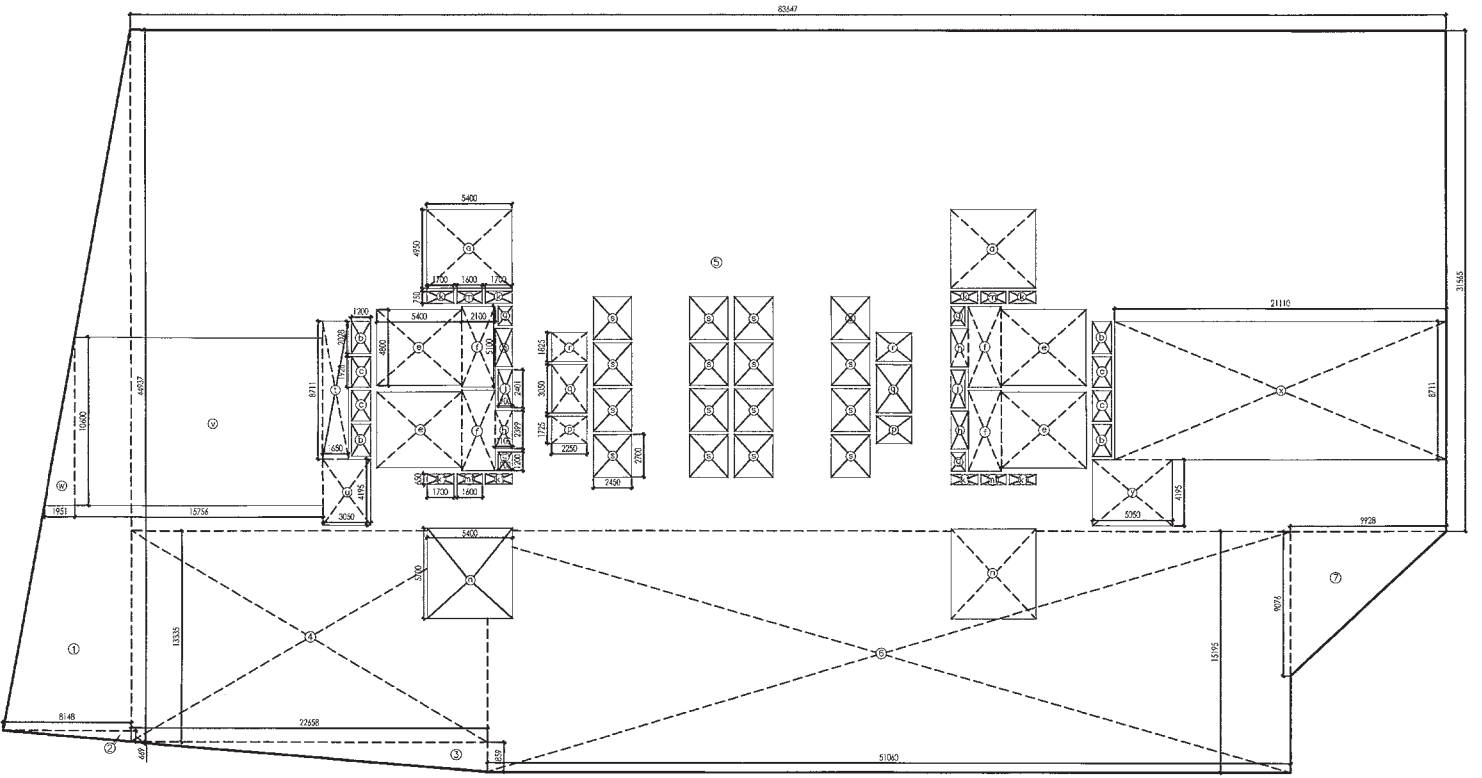


TYPICAL REFUSE(7TH,11TH & 15TH) FLOOR
BLOCK-B

TYPICAL FLOOR (2nd to 6th, 8th to 10th, 12th to 14th, 16th to 17th) AREA CALCULATION			
GROSS - A			
1	= 0.5 X 8.148 X 44.268	=	180.348 SQM
2	= 0.5 X 0.899 X 8.148	=	2.726 SQM
3	= 0.5 X 1.859 X 22.658	=	21.091 SQM
4	= 1 X 22.658 X 13.335	=	302.144 SQM
5	= 1 X 83.847 X 31.563	=	2641.823 SQM
6	= 1 X 51.080 X 15.195	=	775.857 SQM
7	= 0.5 X 9.028 X 9.076	=	45.053 SQM
TOTAL			= 3969.012 SQM
GROSS - B			
a	= 2 X 5.400 X 4.950	=	53.460 SQM
b	= 4 X 1.200 X 2.025	=	9.720 SQM
c	= 4 X 1.200 X 1.828	=	8.584 SQM
d	= 4 X 5.400 X 4.850	=	103.680 SQM
e	= 4 X 2.250 X 4.100	=	42.840 SQM
f	= 4 X 0.900 X 1.200	=	4.320 SQM
g	= 4 X 1.350 X 2.359	=	10.566 SQM
h	= 2 X 0.900 X 2.401	=	4.322 SQM
i	= 4 X 1.200 X 0.750	=	3.600 SQM
j	= 4 X 1.200 X 0.600	=	2.880 SQM
k	= 2 X 1.800 X 0.250	=	0.900 SQM
l	= 1 X 1.800 X 0.600	=	1.080 SQM
m	= 2 X 1.800 X 0.250	=	0.900 SQM
n	= 2 X 1.800 X 0.600	=	2.160 SQM
o	= 2 X 5.400 X 4.850	=	52.380 SQM
p	= 2 X 2.250 X 1.725	=	7.725 SQM
q	= 2 X 2.250 X 3.060	=	13.725 SQM
r	= 2 X 2.250 X 1.625	=	7.312 SQM
s	= 2 X 2.400 X 2.700	=	10.800 SQM
t	= 2 X 2.700 X 2.480	=	13.475 SQM
TOTAL			= 440.698 SQM
FAR AREA OF TYPICAL FLOOR (2nd to 6th, 8th to 10th, 12th to 14th, 16th to 17th)			
GROSS - A			= GROSS - B
			= 3969.012
			= 3428.925 SQM

TYPICAL REFUSE (7th, 11th & 15th) FLOOR AREA CALCULATION			
GROSS - A			
1	= 0.5 X 8.148 X 44.268	=	180.348 SQM
2	= 0.5 X 0.899 X 8.148	=	2.726 SQM
3	= 0.5 X 1.859 X 22.658	=	21.091 SQM
4	= 1 X 22.658 X 13.335	=	302.144 SQM
5	= 1 X 83.847 X 31.563	=	2641.823 SQM
6	= 1 X 51.080 X 15.195	=	775.857 SQM
7	= 0.5 X 9.028 X 9.076	=	45.053 SQM
TOTAL			= 3969.012 SQM
GROSS - B			
a	= 2 X 5.400 X 4.950	=	53.460 SQM
b	= 4 X 1.200 X 2.025	=	9.720 SQM
c	= 4 X 1.200 X 1.828	=	8.584 SQM
d	= 4 X 5.400 X 4.850	=	103.680 SQM
e	= 4 X 2.250 X 4.100	=	42.840 SQM
f	= 4 X 0.900 X 1.200	=	4.320 SQM
g	= 4 X 1.350 X 2.359	=	10.566 SQM
h	= 2 X 0.900 X 2.401	=	4.322 SQM
i	= 4 X 1.200 X 0.750	=	3.600 SQM
j	= 4 X 1.200 X 0.600	=	2.880 SQM
k	= 2 X 1.800 X 0.250	=	0.900 SQM
l	= 1 X 1.800 X 0.600	=	1.080 SQM
m	= 2 X 1.800 X 0.250	=	0.900 SQM
n	= 2 X 1.800 X 0.600	=	2.160 SQM
o	= 2 X 5.400 X 4.850	=	52.380 SQM
p	= 2 X 2.250 X 1.725	=	7.725 SQM
q	= 2 X 2.250 X 3.060	=	13.725 SQM
r	= 2 X 2.250 X 1.625	=	7.312 SQM
s	= 2 X 2.400 X 2.700	=	10.800 SQM
t	= 2 X 2.700 X 2.480	=	13.475 SQM
TOTAL			= 440.698 SQM
FAR AREA OF TYPICAL REFUSE (7th, 11th & 15th) FLOOR			
GROSS - A			= GROSS - B
			= 3969.012
			= 3412.159 SQM

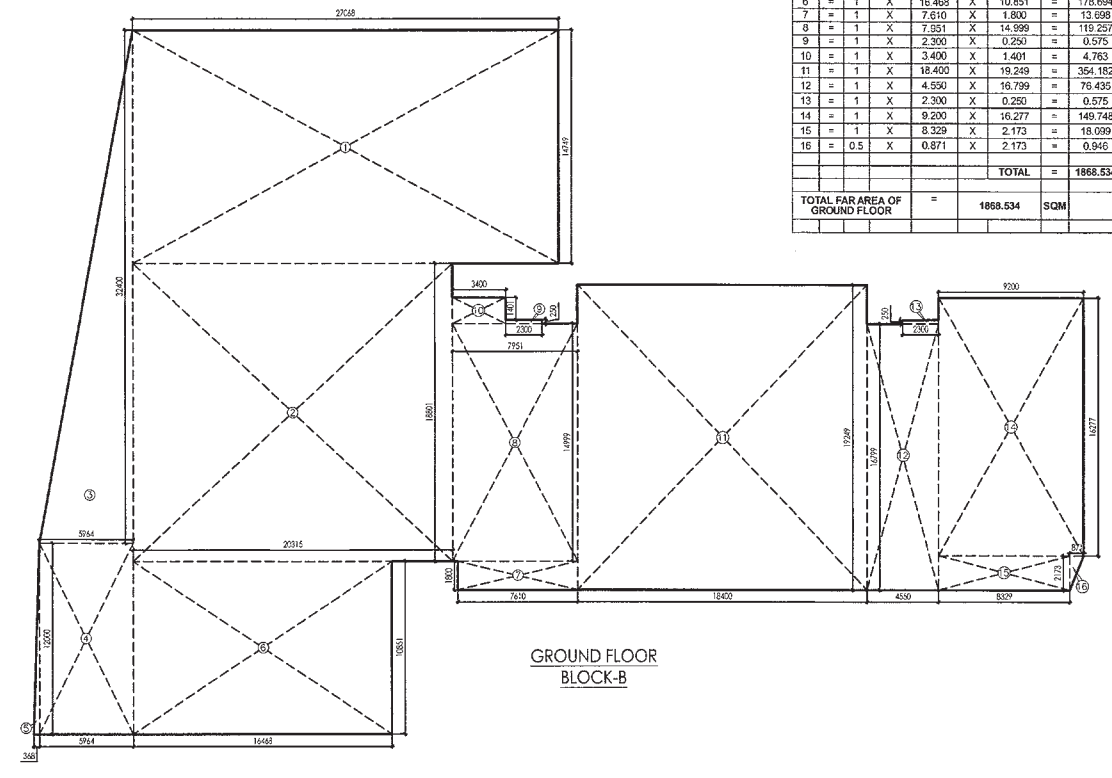

GROUND FLOOR
BLOCK-B

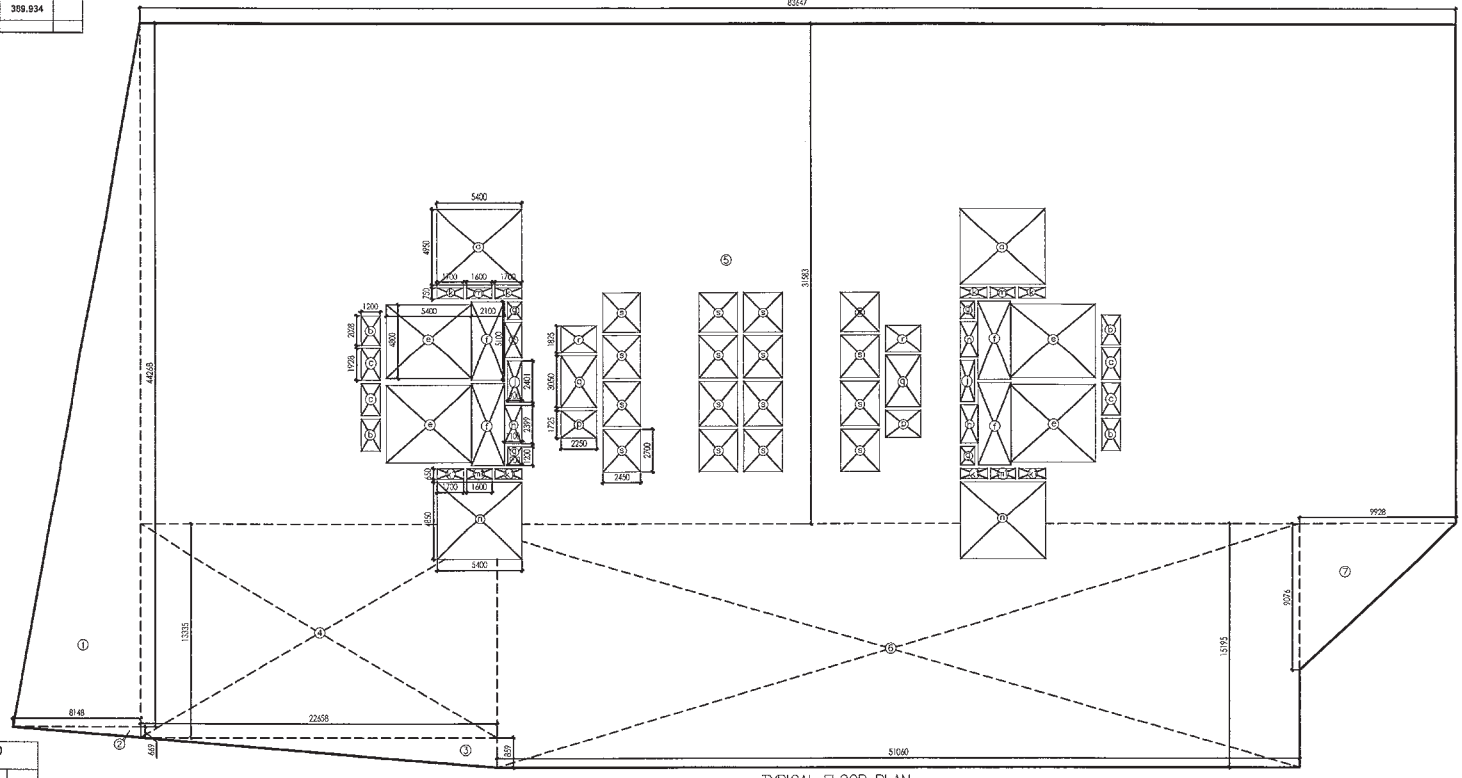

TYPICAL FLOOR PLAN
(2nd to 6th, 8th to 10th, 12th to 14th, 16th to 17th)
BLOCK-B

GROUND FLOOR AREA (TOWERS)			
GROSS - A			
1	= 1 X 27.983 X 14.749	=	399.238 SQM
2	= 1 X 20.315 X 18.291	=	369.842 SQM
3	= 0.5 X 5.864 X 32.400	=	95.817 SQM
4	= 1 X 5.964 X 17.000	=	71.664 SQM
5	= 0.5 X 0.368 X 12.000	=	2.208 SQM
6	= 1 X 16.668 X 13.851	=	178.694 SQM
7	= 1 X 7.610 X 1.800	=	13.698 SQM
8	= 1 X 7.551 X 14.989	=	112.251 SQM
9	= 1 X 2.300 X 0.250	=	0.575 SQM
10	= 1 X 3.400 X 1.401	=	4.763 SQM
11	= 1 X 18.400 X 19.259	=	352.182 SQM
12	= 1 X 4.550 X 19.799	=	78.435 SQM
13	= 1 X 2.300 X 0.250	=	0.575 SQM
14	= 1 X 9.200 X 16.277	=	149.748 SQM
15	= 1 X 8.529 X 2.173	=	18.099 SQM
16	= 0.5 X 0.871 X 2.173	=	0.945 SQM
TOTAL			= 1868.534 SQM
TOTAL FAR AREA OF GROUND FLOOR			
			= 1868.534 SQM


DRG NO. BB-07

This is a "PROVISIONAL BUILDING PLAN" approved only for the purpose of inviting objections from the general public.

Architect: Hafeez Contractor
 Engineer: R. S. Misra
 Surveyor: S. K. Singh
 Draftsman: B. K. Singh

DLF49922

KEY PLAN

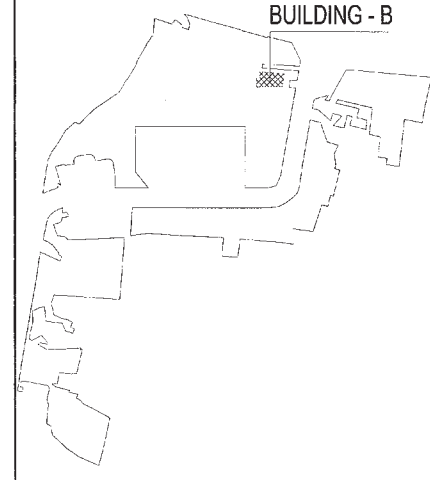

BUILDING - B

**Architect
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Contractor**
29 Bank Street, Sankhy 408 013, Tel: 26260929

RISIMIS
ARCHITECTS

RSMS ARCHITECTS PVT. LTD.
69, Nara Niwas Bhawani Kunj
(Behind D2), Vasant Kunj,
New Delhi-110070.
Tel.: 011-26898616, 26898617
www.rsms-arch.com

PROPOSED BUILDING PLANS OF BUILDING - B AND REVISED BUILDING PLANS OF BUILDING - C, D, E, & F IN CYBER CITY UNDER TRANSIT ORIENTED DEVELOPMENT (TOD) POLICY FOR MIX LAND USED COLONY (70% IT/ITES/+30% COMMERCIAL) MEASURING 108.55922 ACRES IN SECTOR 24, 25 & 25-A, GURUGRAM MANESAR URBAN COMPLEX BEING DEVELOPED BY DLF CYBER CITY DEVELOPERS LIMITED

OWNER: DLF Cyber City Developers Ltd.
10th Floor DLF Gateway Tower,
DLF Cyber City, Gurugram, Haryana
Pin: 122002

DRAWING TITLE: --
AREA CALCULATION OF GROUND COVERAGE & GROUND TO 17TH FLOOR BLOCK-B

REVISION: JOB NO: -- DRG NO. BB-07 NORTH: --
SCALE: 1:200 DATE: 01-04-2021

FILE: -- DEALT BY: -- CHECKED BY: -- APPROVED BY: --

ARCHITECT'S SEAL & SIGNATURE: OWNER'S SEAL & SIGNATURE: