

NO.	DESCRIPTION	UNIT	QTY	AREA	STATUS
1	GROSS-B	SQM	297,251		
2	GROSS-A	SQM	105,843		
3	GROSS-C	SQM	117,263		
4	GROSS-D	SQM	223,733		
5	GROSS-E	SQM	459,130		
6	GROSS-F	SQM	580,238		
7	GROSS-G	SQM	853,368		
8	GROSS-H	SQM	1,939,368.3170		
9	GROSS-I	SQM	295,181		
10	GROSS-J	SQM	235,061		
11	GROSS-K	SQM	297,251		
12	GROSS-L	SQM	520,884		
13	GROSS-M	SQM	223,733		
14	GROSS-N	SQM	459,130		
15	GROSS-O	SQM	1,939,368.3170		
16	GROSS-P	SQM	295,181		
17	GROSS-Q	SQM	235,061		
18	GROSS-R	SQM	297,251		
19	GROSS-S	SQM	520,884		
20	GROSS-T	SQM	223,733		
21	GROSS-U	SQM	459,130		
22	GROSS-V	SQM	1,939,368.3170		
23	GROSS-W	SQM	295,181		
24	GROSS-X	SQM	235,061		
25	GROSS-Y	SQM	297,251		
26	GROSS-Z	SQM	520,884		
27	GROSS-AA	SQM	223,733		
28	GROSS-AB	SQM	459,130		
29	GROSS-AC	SQM	1,939,368.3170		
30	GROSS-AD	SQM	295,181		
31	GROSS-AE	SQM	235,061		
32	GROSS-AF	SQM	297,251		
33	GROSS-AG	SQM	520,884		
34	GROSS-AH	SQM	223,733		
35	GROSS-AI	SQM	459,130		
36	GROSS-AJ	SQM	1,939,368.3170		
37	GROSS-AM	SQM	295,181		
38	GROSS-AN	SQM	235,061		
39	GROSS-AP	SQM	297,251		
40	GROSS-AQ	SQM	520,884		
41	GROSS-AR	SQM	223,733		
42	GROSS-AS	SQM	459,130		
43	GROSS-AT	SQM	1,939,368.3170		
44	GROSS-AU	SQM	295,181		
45	GROSS-AV	SQM	235,061		
46	GROSS-AW	SQM	297,251		
47	GROSS-AX	SQM	520,884		
48	GROSS-AY	SQM	223,733		
49	GROSS-AZ	SQM	459,130		
50	GROSS-BA	SQM	1,939,368.3170		




REFUGED AREA CALCULATION
(7TH,11TH,15TH FLOOR)

19600
19600
19600
19600

5200
5200
5200
5200

DOOR SCHEDULE

NO.	DESCRIPTION	UNIT	QTY
1	DOOR	UNIT	100
2	WINDOW	UNIT	200
3	FLOOR	UNIT	50
4	CEILING	UNIT	100
5	ROOF	UNIT	10
6	STAIR	UNIT	20
7	LIFT	UNIT	5
8	ELECTRICAL	UNIT	150
9	PLUMBING	UNIT	150
10	MECHANICAL	UNIT	150
11	PAINT	UNIT	2000
12	FURNITURE	UNIT	100
13	APPLIANCE	UNIT	50
14	GLASS	UNIT	100
15	METAL	UNIT	100
16	WOOD	UNIT	100
17	CEMENT	UNIT	100
18	BLOCK	UNIT	100
19	BRICK	UNIT	100
20	ROOFING	UNIT	100
21	INSULATION	UNIT	100
22	WATER	UNIT	100
23	ELECTRICAL	UNIT	100
24	MECHANICAL	UNIT	100
25	PLUMBING	UNIT	100
26	PAINT	UNIT	1000
27	FURNITURE	UNIT	100
28	APPLIANCE	UNIT	50
29	GLASS	UNIT	100
30	METAL	UNIT	100
31	WOOD	UNIT	100
32	CEMENT	UNIT	100
33	BLOCK	UNIT	100
34	BRICK	UNIT	100
35	ROOFING	UNIT	100
36	INSULATION	UNIT	100
37	WATER	UNIT	100
38	ELECTRICAL	UNIT	100
39	MECHANICAL	UNIT	100
40	PLUMBING	UNIT	100
41	PAINT	UNIT	1000
42	FURNITURE	UNIT	100
43	APPLIANCE	UNIT	50
44	GLASS	UNIT	100
45	METAL	UNIT	100
46	WOOD	UNIT	100
47	CEMENT	UNIT	100
48	BLOCK	UNIT	100
49	BRICK	UNIT	100
50	ROOFING	UNIT	100
51	INSULATION	UNIT	100
52	WATER	UNIT	100
53	ELECTRICAL	UNIT	100
54	MECHANICAL	UNIT	100
55	PLUMBING	UNIT	100
56	PAINT	UNIT	1000
57	FURNITURE	UNIT	100
58	APPLIANCE	UNIT	50
59	GLASS	UNIT	100
60	METAL	UNIT	100
61	WOOD	UNIT	100
62	CEMENT	UNIT	100
63	BLOCK	UNIT	100
64	BRICK	UNIT	100
65	ROOFING	UNIT	100
66	INSULATION	UNIT	100
67	WATER	UNIT	100
68	ELECTRICAL	UNIT	100
69	MECHANICAL	UNIT	100
70	PLUMBING	UNIT	100
71	PAINT	UNIT	1000
72	FURNITURE	UNIT	100
73	APPLIANCE	UNIT	50
74	GLASS	UNIT	100
75	METAL	UNIT	100
76	WOOD	UNIT	100
77	CEMENT	UNIT	100
78	BLOCK	UNIT	100
79	BRICK	UNIT	100
80	ROOFING	UNIT	100
81	INSULATION	UNIT	100
82	WATER	UNIT	100
83	ELECTRICAL	UNIT	100
84	MECHANICAL	UNIT	100
85	PLUMBING	UNIT	100
86	PAINT	UNIT	1000
87	FURNITURE	UNIT	100
88	APPLIANCE	UNIT	50
89	GLASS	UNIT	100
90	METAL	UNIT	100
91	WOOD	UNIT	100
92	CEMENT	UNIT	100
93	BLOCK	UNIT	100
94	BRICK	UNIT	100
95	ROOFING	UNIT	100
96	INSULATION	UNIT	100
97	WATER	UNIT	100
98	ELECTRICAL	UNIT	100
99	MECHANICAL	UNIT	100
100	PLUMBING	UNIT	100

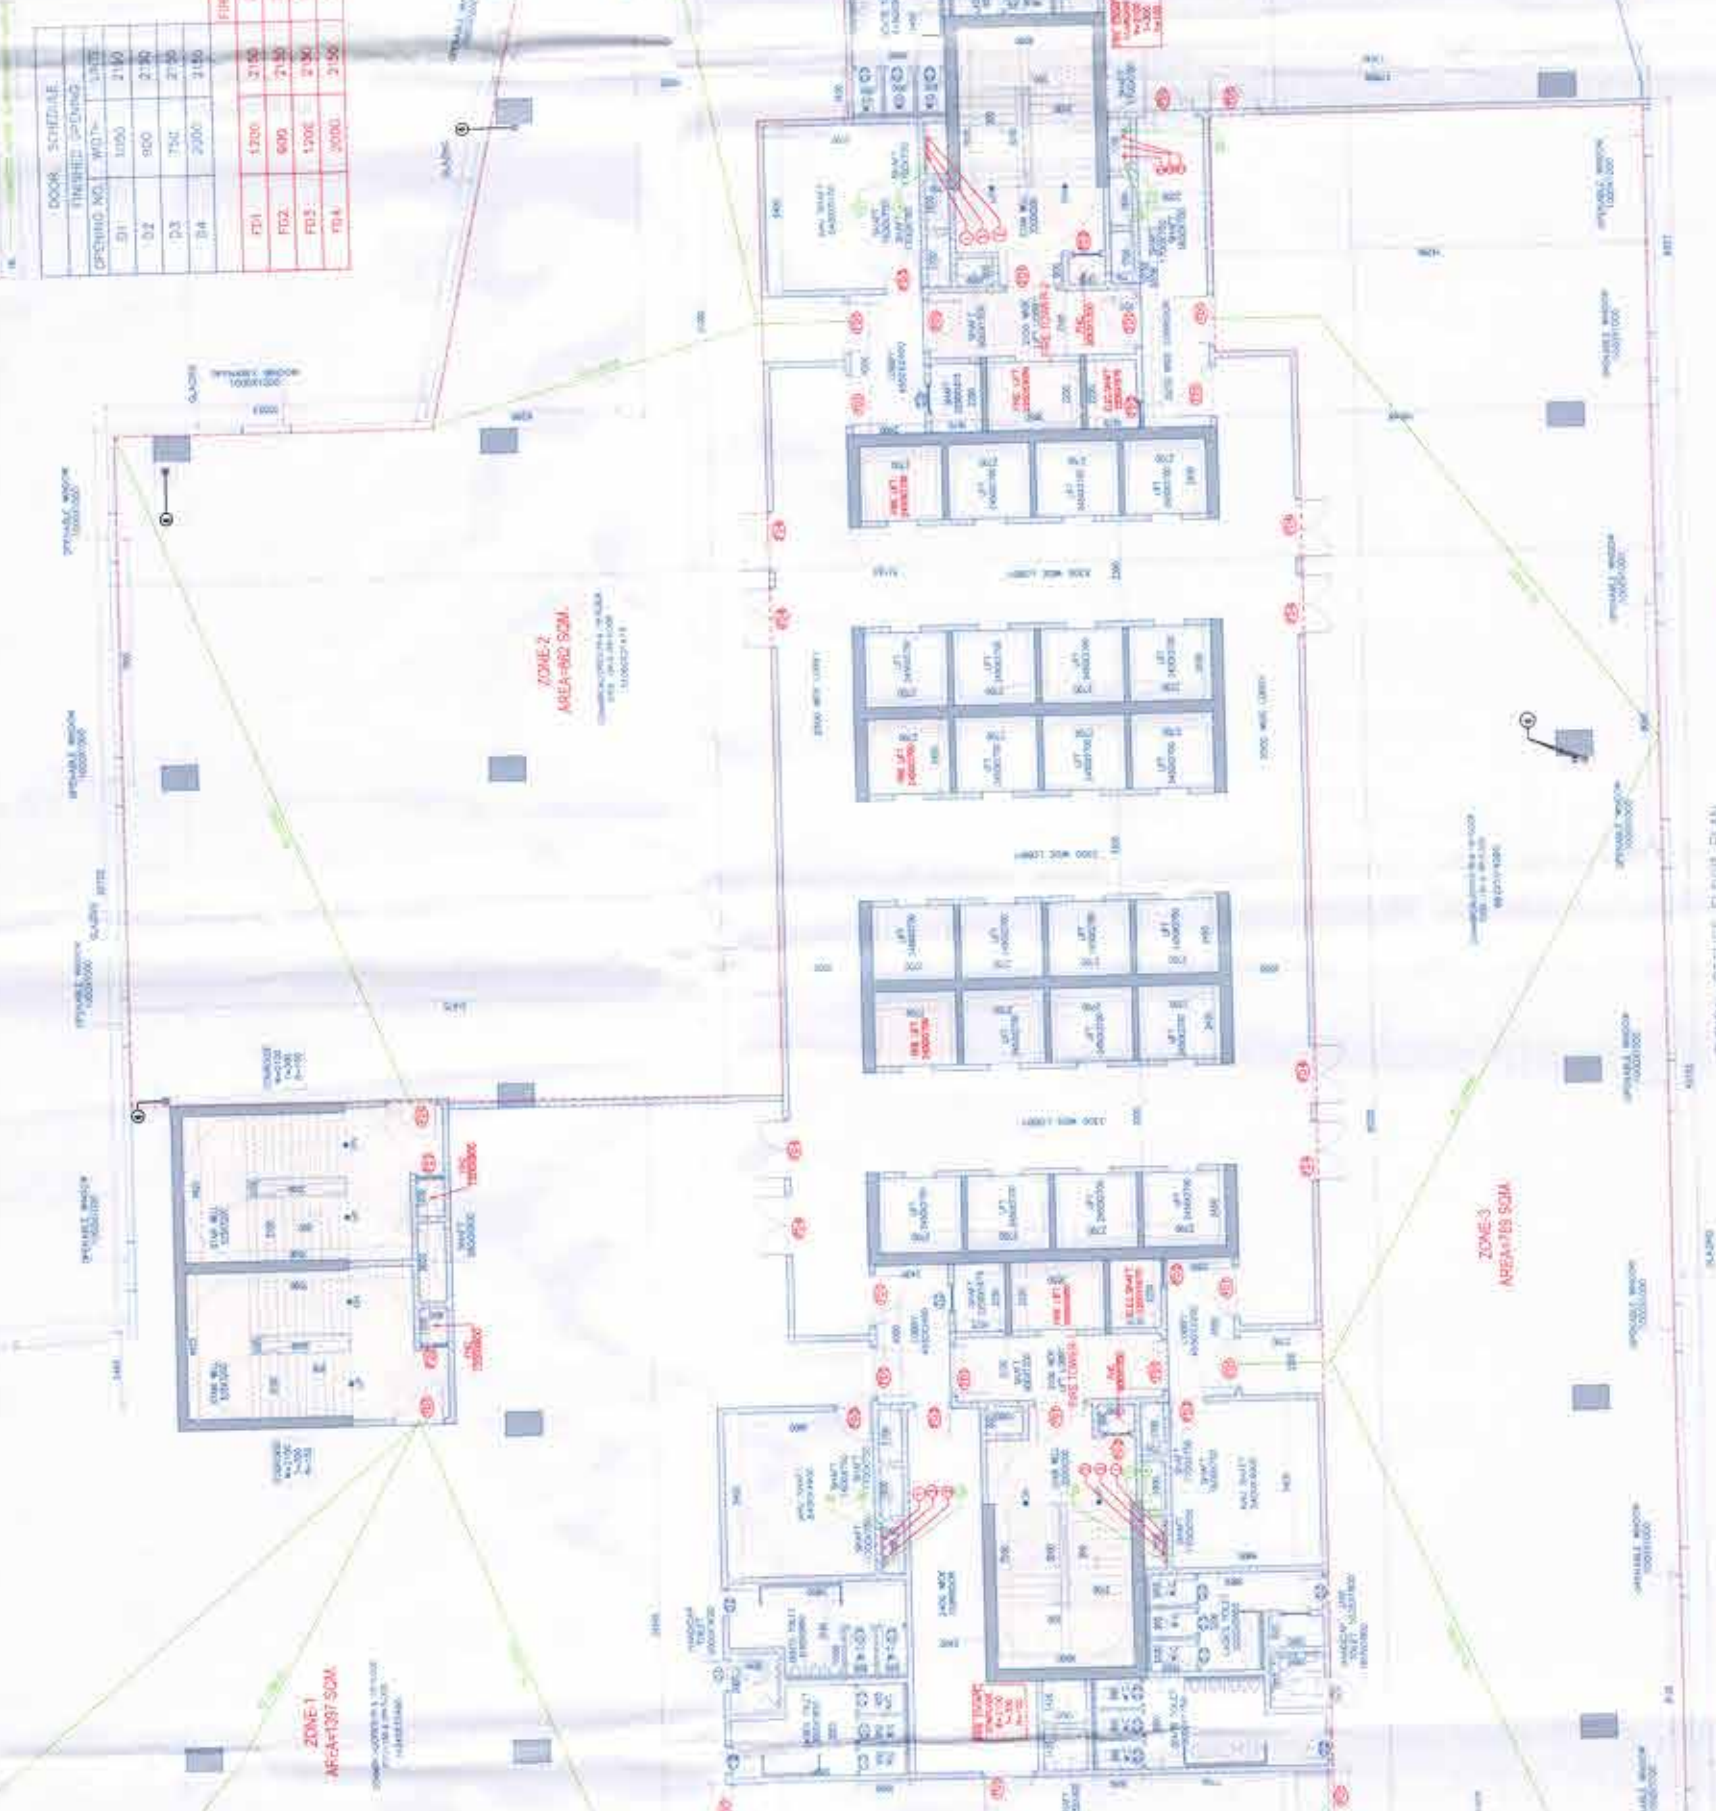

Architect
Hafeez Contractor

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www.risimis-arch.com

REVEED BUILDING PLANS OF BUILDING-B
C, D, E & F OF CYBER CITY UNDER TRANSIT
ORIENTED DEVELOPMENT (TOO) POLICY FOR
MIX LAND USED COLONY/ZONE 17/TIES/1-50%
COMMERCIAL MEASURING 108-5522 ACRES
IN SECTOR 24, 25 & 25-A, GURGOGRAM
GATEWAY INDIA COMPLEX BEING
DEVELOPED BY
DLF CYBER CITY DEVELOPERS LIMITED

DLF

DRAWING TITLE:-
TYPICAL REFUGE FLOOR PLAN
BLOCK E

REV	NO.	DESCRIPTION	DATE	BY	CHKD BY
	01	ISSUED FOR PERMIT	25-04-2017		

APPROVED BY: [Signature]
DATE: 25-04-2017

DWG NO: [Blank]
SCALE: 1:100
PROJ. NO: [Blank]

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