


NO.	MARK	DESCRIPTION
01	100	100 TO 200 PIPE
02	200	200 TO 300 PIPE
03	300	300 TO 400 PIPE
100	10000	10000 TO 10100 PIPE

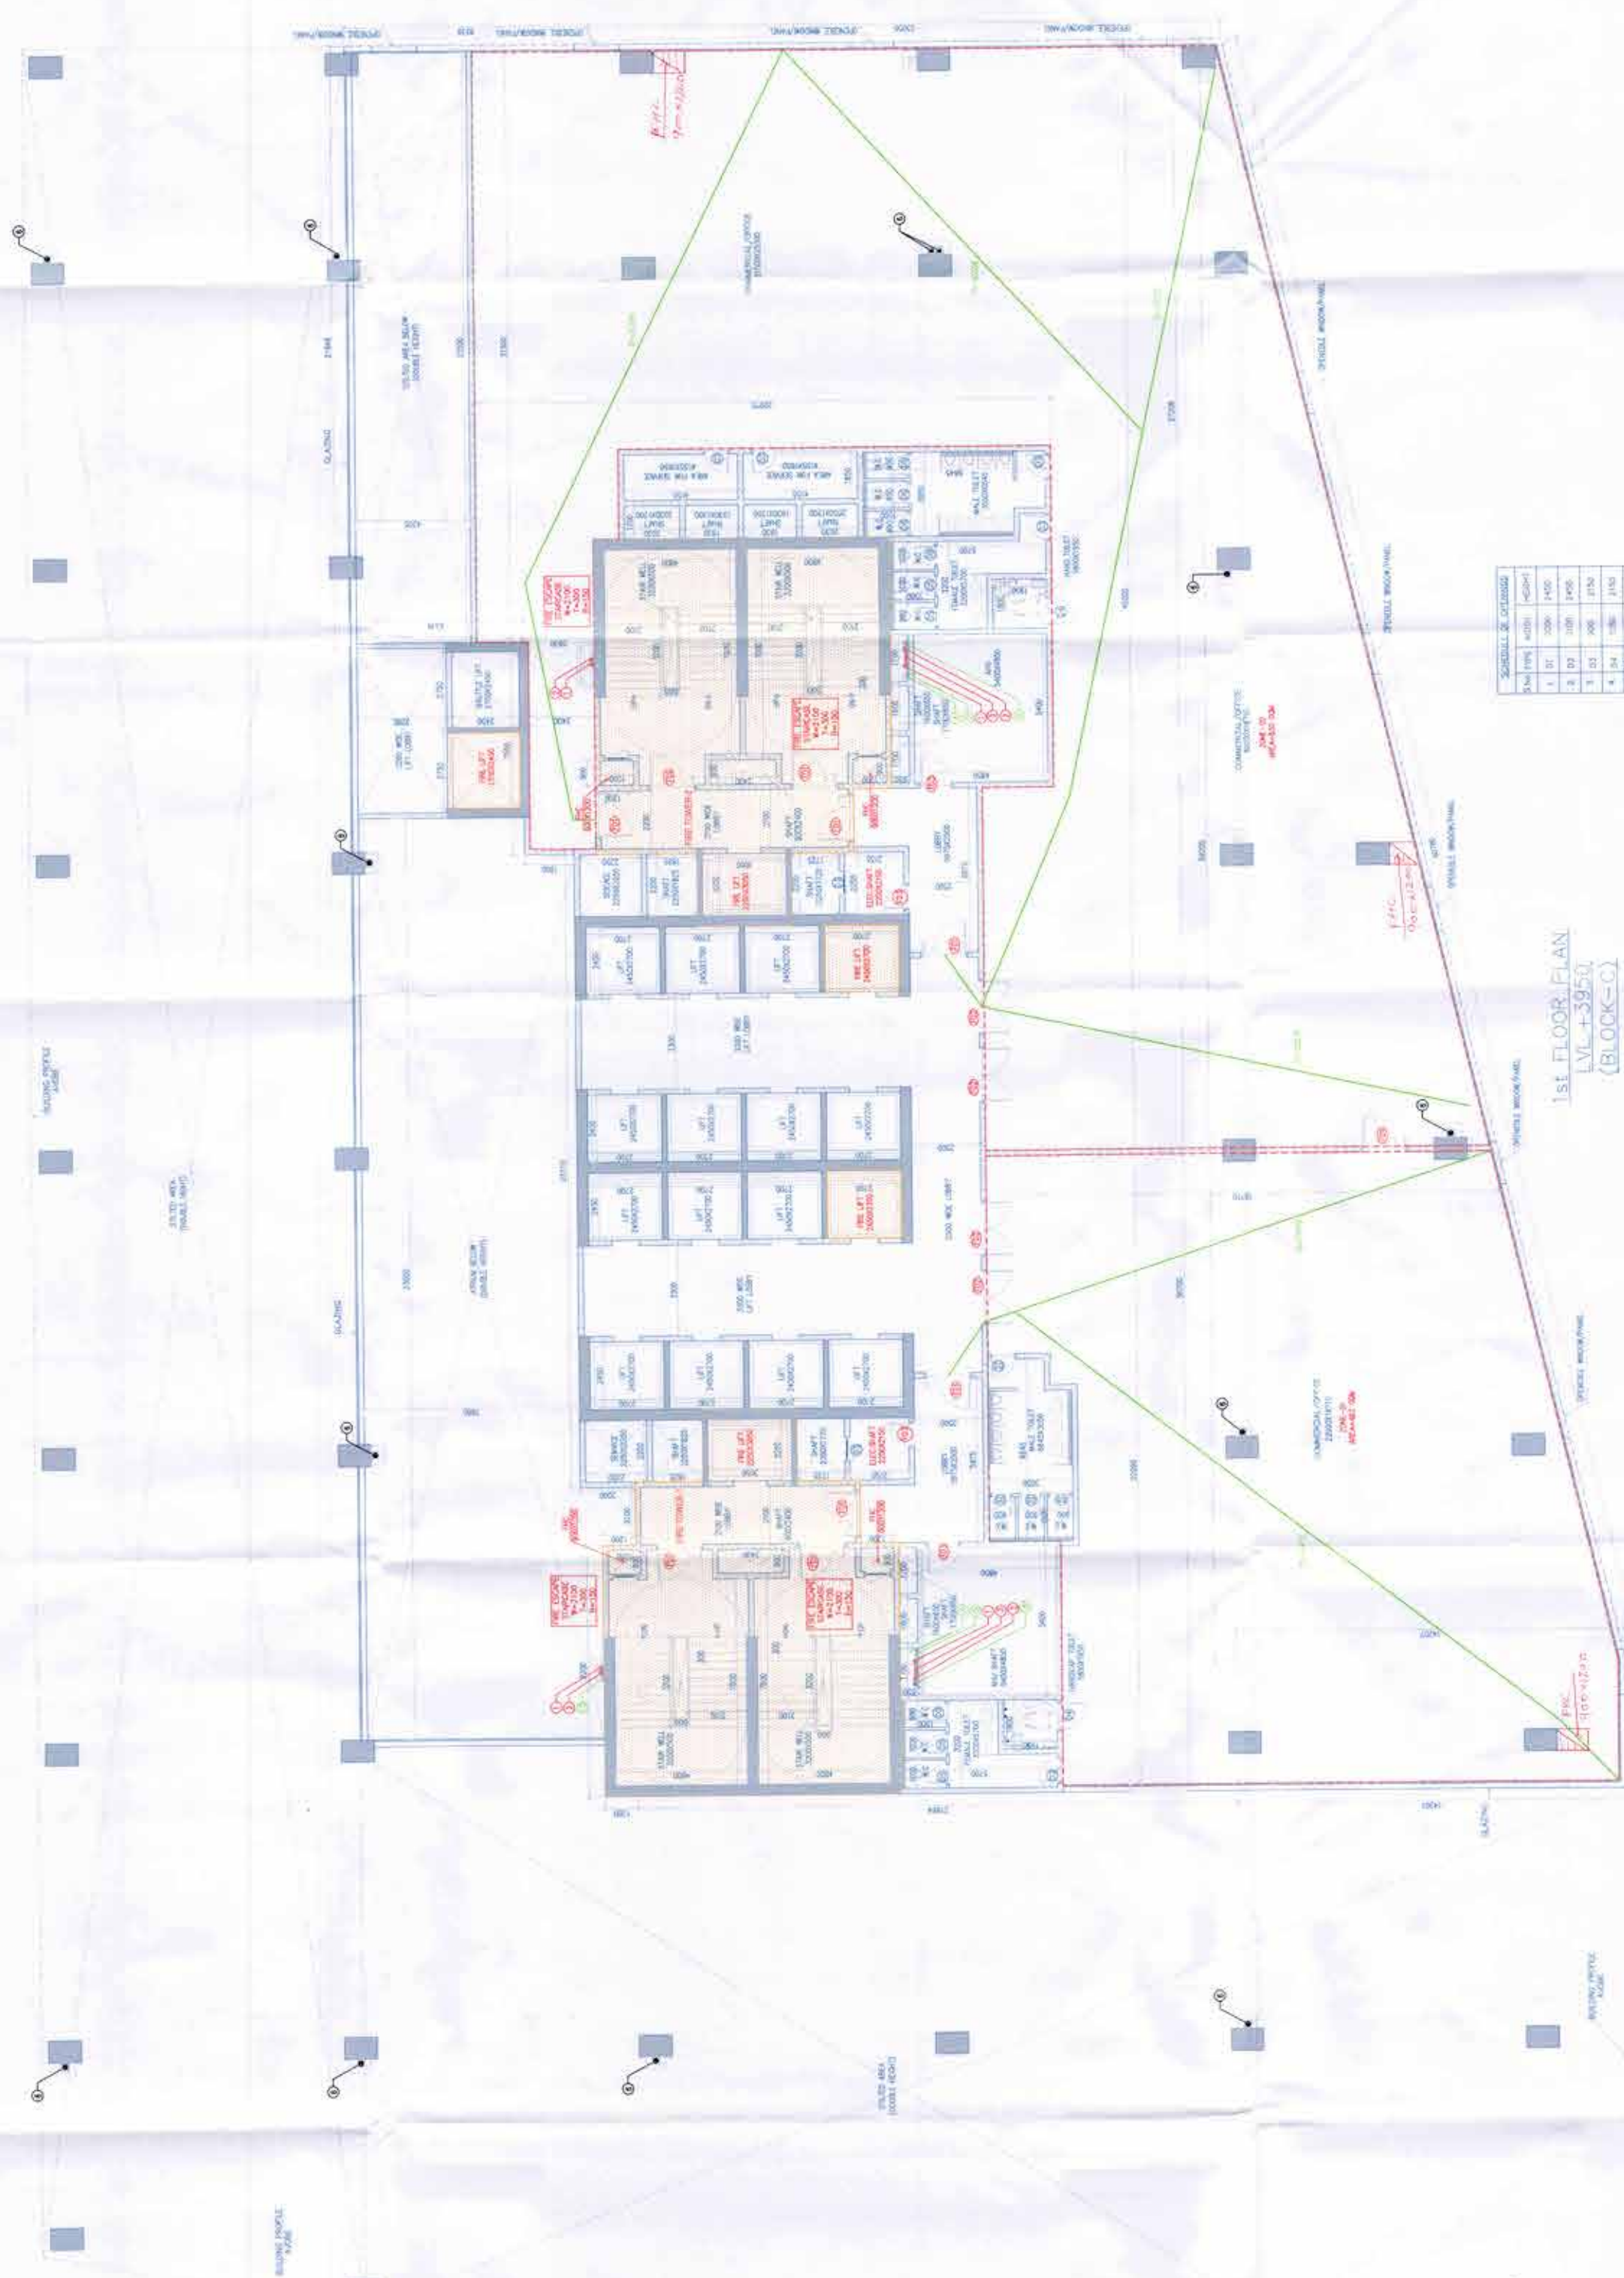


STAIRCASE NO.	WIDTH (MM)	LENGTH (MM)	AREA (SQ. MM)	PERF. PER FLOOR (MM)	TOTAL STAIRCASE WIDTH (MM)	TOTAL STAIRCASE LENGTH (MM)	TOTAL STAIRCASE AREA (SQ. MM)	TOTAL STAIRCASE PER FLOOR (MM)
1	1200	1400	1680000	1200	1200	1400	1680000	1200
2	1200	1400	1680000	1200	1200	1400	1680000	1200
3	1200	1400	1680000	1200	1200	1400	1680000	1200
4	1200	1400	1680000	1200	1200	1400	1680000	1200
5	1200	1400	1680000	1200	1200	1400	1680000	1200
6	1200	1400	1680000	1200	1200	1400	1680000	1200
7	1200	1400	1680000	1200	1200	1400	1680000	1200
8	1200	1400	1680000	1200	1200	1400	1680000	1200
9	1200	1400	1680000	1200	1200	1400	1680000	1200
10	1200	1400	1680000	1200	1200	1400	1680000	1200
11	1200	1400	1680000	1200	1200	1400	1680000	1200
12	1200	1400	1680000	1200	1200	1400	1680000	1200
13	1200	1400	1680000	1200	1200	1400	1680000	1200
14	1200	1400	1680000	1200	1200	1400	1680000	1200
15	1200	1400	1680000	1200	1200	1400	1680000	1200
16	1200	1400	1680000	1200	1200	1400	1680000	1200
17	1200	1400	1680000	1200	1200	1400	1680000	1200
18	1200	1400	1680000	1200	1200	1400	1680000	1200
19	1200	1400	1680000	1200	1200	1400	1680000	1200
20	1200	1400	1680000	1200	1200	1400	1680000	1200

1ST FLOOR PLAN
LEVEL +3950
(BLOCK-C)

NOTE:-ALL OPENABLE WINDOW / PANEL ARE PROVIDED AT 10M DISTANCE.

BLOCK NAME	FLOOR	AREA (SQ.M)	OCCUPANT LOAD	OCCUPANT LOAD PER FLOOR	TOTAL STAIRCASE WIDTH PER FLOOR	TOTAL STAIRCASE WIDTH REQUIRED	TOTAL STAIRCASE WIDTH PROVIDED	PROVIDED NO. OF STAIRCASES	REQUIRED NO. OF STAIRCASES
BLOCK-C	1ST FLOOR-OFFICE	208343	1 per 15 Sqm.	208	208	208	208	3	3

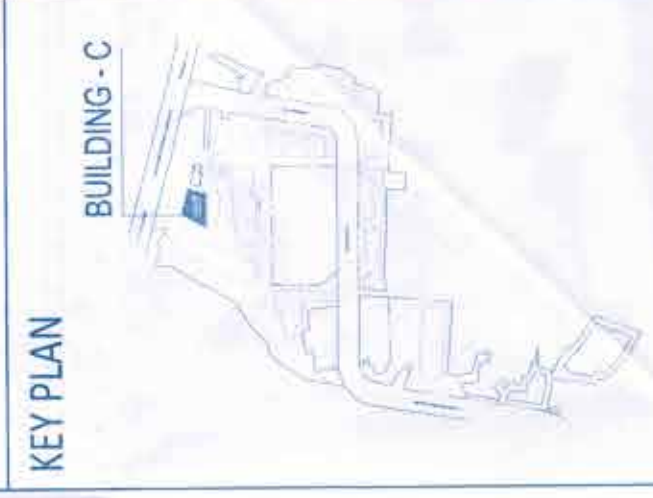

Architect
Hafeez
Contractor

RISIMIS
ARCHITECTS

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DLF Cyber City Gurgaon, Gurgaon
Pin 122002

PROJECT: 10th Floor DLF Cybercity Tower,
DLF Cyber City Gurgaon, Gurgaon
Pin 122002

SCALE: 1:100
DATE: 25-04-2022

APPROVED BY: [Signature]
DRAWING TITLE: 1ST FLOOR PLAN
BLOCK-C

